MECHANICAL SYSTEM NOTES

- 1. A NEW SUPPLY AND RETURN HVAC SYSTEM SHALL BE DESIGNED AND CONNECTED TO THE EXISTING BUILDING SYSTEM.

 A SHOP DRAWING SHOWING THE PROPOSED LOCATION OF ALL DIFFUSERS, EXHAUST FANS, RETURNS [INDIVIDUAL RETURNS IN EACH ROOM OR SPACE NOT A SINGLE CENTRAL RETURN], ACCESSIBLE CONTROLS, CONTROL WIRING, ETC. SHALL BE SUBMITTED TO THE ARCHITECTS FOR THEIR APPROVAL WITHIN 2 WEEKS OF THE TIME THE CONSTRUCTION CONTRACT IS AWARDED. (VERIFY FINAL LIGHTING LAYOUT) ARCHITECT SHALL HAVE THE RIGHT TO HAVE THE MECH. SUB—CONTRACTOR MAKE ANY FIELD CHANGES THEY DEEM NECESSARY IF THEY HAVE NOT HAD AN OPPORTUNITY TO REVIEW THE SHOP DRAWINGS.
 - MANDATORY FEATURES FOR MECHANICAL ENERGY COMPLIANCE.

 THE CONTRACTOR SHALL VISIT THE SITE SO AS TO EVALUATE THE EXISTING CONDITIONS AND DETERMINE WHAT WORK WILL BE NECESSARY IN ORDER TO PROVIDE A COMPLETE AND EFFECTIVELY

ALL DUCTWORK TO BE INSULATED AND SYSTEM SHALL INCLUDE OTHER

- 2. THE REMAINDER OF THE HVAC SYSTEM: THE INSULATED SUPPLY AND RETURN DUCTS, CEILING DIFFUSERS, CONTROL SYSTEM WITH A 7-DAY CLOCK AND THE EXHAUST FANS ARE A PART OF THIS CONTRACT. FURNISH A SEPARATE BID TO INCLUDE ALL OF THE ELEMENTS TO COMPLETE THE HVAC SYSTEM.
- A DESCRIPTION OF THE PROPOSED SYSTEM SHALL BE SUBMITTED WITH THE BID SO AS TO BE EVALUATED FOR ITS PERFORMANCE CAPABILITIES AND FOR COMPARISON WITH OTHER PROPOSED SYSTEMS.
- 3. THE CONTRACT SHALL INCLUDE TESTING & BALANCING
- OF THE SYSTEM.

 4. EXHAUST FAN SCHEDULE:
- FANS (w/ BACKDRAFT DAMPERS)


 5, 8, 16 & 18
 BSMNT. MECH. RM.

 FANS (w/ BACKDRAFT DAMPERS)

 PANASONIC #FV- 15VQ4 (150 CFM)
- 9 VERIFY SIZE SEE NOTE #6 BELOW

 [FAN AT BASEMENT TO BE INTERCONNECTED w/ COMPRESSOR SO AS TO SWITCH ON AUTOMATICALLY WHENEVER COMPRESSOR IS OPERATING.]

 NOTE: IN BASEMENT MECHANICAL ROOM, FURNISH A 36 SQ. IN. METAL DUCT TO THE EXTERIOR, STARTING AT 24" A.F.F. AND NEAR THE COMPRESSOR.
- 5. PROVIDE EXHAUST VENT FROM VENT HOOD AS NOTED AT ROOM #8
- 6. PROVIDE VENT TO BASEMENT FOR STERILIZER AT ROOM #9. COORDINATE w/ CABINET MAKER SEE CAB. DWGS. W & X/C4
- 7. CONSULT w/ LOW-VOLTAGE SUPPLIER/CONTRACTOR REGARDING COOLING REQUIREMENTS FOR ROOM #15.

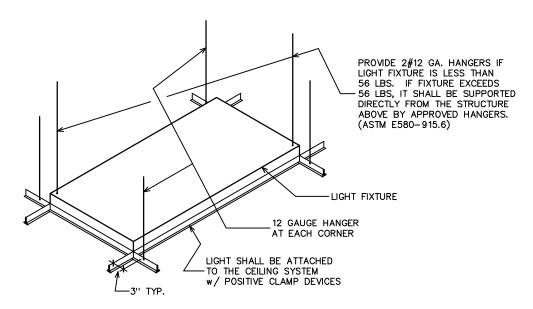

LIGHT FIXTURE SUPPORT DETAIL

WALL ASSEMBLY DETAIL

SCALE: 1/2" = 1'-0"

SIMILAR FOR GYP. BD. CEILING

'USG' DON	N COMPRESSION POST		METAL PIF	PE STRU	TS		
MODEL #	. # ALLOWABLE LENGTH		TRADE	ALLOWABLE LENGTH			
VSA 12	1'-6" TO 2'-6"		SIZE	EMT	IMC	RMC	
VSA 24	2'-6" TO 4'-0"	1	1/2"	3' 10"	4'-4"	4'-4"	
VSA 47	4'-0" TO 7'-0"	1	3/4"	5'-2"	5'-7''	5'-7"	
VSA 710	7'-0" TO 10'-0"		1''	6'-6"	7'-0''	7'-0"	
VSA 1012	10'-0" TO 12'-0"		1 1/4"	8'-6"	9'-0''	9'-0"	45°-0'
			1 1/2"	9'– 10''	10'-5"	10'-5''	\checkmark
TO EXISTING STRI OR OTHER OBSTA 45° (MAX) DIAGO ABOVE @ 8'-0"	TUD KICKERS AT 8'-0" O.C. UCTURE ABOVE. IF DUCT WORK ACLES ARE IN THE WAY USE NAL BRACING TO STRUCTURE O.C BRACING TO BE 25 GA. E TRACKS - COPE FLANGE & CONNECTION		2" EMT - ELECTR IMC - INTERM RMC - RIGID M	EDIATE META	AL CONDUIT	13'-2"	
FASTENERS FOR STEEL TO WOOD					/		ISO.
STEEL TO STEEL SUSPENDED CEILI	METAL SCREWS		4'-	0"		\	
(WALL PARTITI 2" MIN. AB	STUD TOP PLATE ON EXTENDS OVE CEILING) TUDS @ 16" O.C. WITH GYP. BD. EACH SIDE (U.O.N.)		MAX. FROM	M WALL			
SEE SYMBOL LEG	END, SHEET A1. RE SHOWN AS AN				8'-0" (TYP)		—
TO EXISTING FLO DRIVEN FASTENEI 'HILTI' X-DW PIN 1" x 0.118" DIAM	RS @ 32" O.C. S (OR EQUAL)						

CEILING CONSTRUCTION


- NOTE: FOR INFORMATION REGARDING LUMINOUS DIFFUSERS, SKY-LIGHTS & SPECIAL CEILING ASSEMBLIES, CONTACT: GORDON, INC., SHREVEPORT, LA. (800) 747-8954 OR NORTON INDUSTRIES (888) 357-2345
- 1. CEILINGS IN ROOMS 2, 3, 4, 5, 6, 8, 10, 11, 13, 15 & 18
 AND ALL CLOSETS & SOFFITS ARE TO BE GYPSUM BOARD.
 SFF SHEFT ID—1
- EXCEPT AS NOTED ABOVE, ALL CEILINGS ARE TO BE SUSPENDED LAY—IN SYSTEM. FRAMING SHALL COMPLY W/ ASTM C—635. MATCHING WALL MOULDING SHALL DETACHABLY SUPPORT FRAMING. INSTALLATION SHALL COMPLY WITH ASTM C—636. FOLLOW MFR'S SPECIFICATIONS AND SEE ALSO SUSPENDED CEILING SUPPORT DETAIL ON THIS SHEET.

NOTE GRID ORIGIN DIMENSIONS ON PLAN.

- SUSPENSION SYSTEM: U.S.G. TEGULAR LAY-IN T-BAR w/ 9/16" 'FINELINE-1/8' GRID (WHITE)
- TILE: U.S.G. 'GLACIER' TILES 24"x24"x3/4" TEGULAR LAY-IN # 708 (WHITE)
- 3. CONTRACTOR TO PROVIDE ONE (1) FULL BOX OF EACH TYPE OF CEILING TILE FOR OWNER'S FUTURE USE.
- 4. AS NOTED ON SHEET E2, IT IS THE GENERAL CONTRACTOR'S RESPONSIBILITY TO FURNISH & INSTALL THE 'SKYFRAME' LUMINOUS DIFFUSER ASSEMBLY & FOIL REFLECTOR PLENUM. (SEE DETAIL 3/A2 ON THIS SHEET)
- 5. PROVIDE 'SOLATUBE' MODEL #290-DS DAYLIGHTING SYSTEM WHERE SHOWN. PHONE: (888) 765-2882
 INCLUDE 'VUSION' CEILING DIFFUSER
 LOCAL CONTACT/SUPPLIER: GREENSPACE (831) 423-7200
- SEE NOTE ON THE TITLE SHEET (TS) RE: PENETRATIONS & FIRE RESISTIVE 'HOODS' AT LIGHT FIXTURES.
- WHERE PARTIAL TILES ARE SHOWN (e.g., EDGES OF ROOM), TILES ARE TO HAVE A CUT REVEAL EDGE WHICH MATCHES THE WHOLE TILES.
- 8. AT THE BEGINNING OF THE PROJECT, PRIOR TO FRAMING WALLS, ALL CEILING HEIGHTS ARE TO BE VERIFIED RELATIVE TO NEW & EXISTING PIPES, DUCTS, ETC. ARCHITECT TO BE NOTIFIED IMMEDIATELY IF SUFFICIENT SPACE IS NOT AVAILABLE FOR PROPOSED LIGHT FIXTURES & OTHER CEILING ELEMENTS.

GENERAL NOTES


- ADDITIONAL INFORMATION WILL BE FOUND ON THE ELECTRICAL DRAWINGS, SHEETS E1 AND E2
- SEE THE INTERIOR DESIGN DRAWING, SHEET ID1, FOR ADDITIONAL INFORMATION.

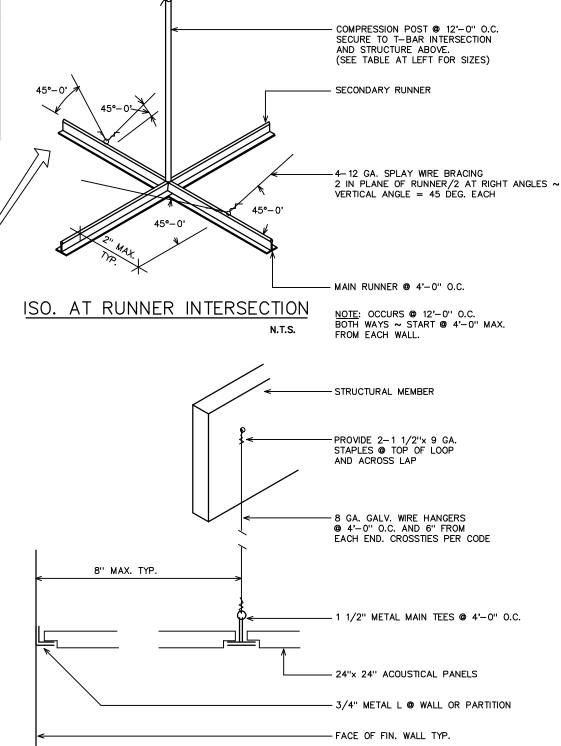



SUSPENDED CEILING SUPPORT DETAIL
NO SCALE

REFLECTED CEILING PLAN

SCALE: 1/4'' = 1'-0''

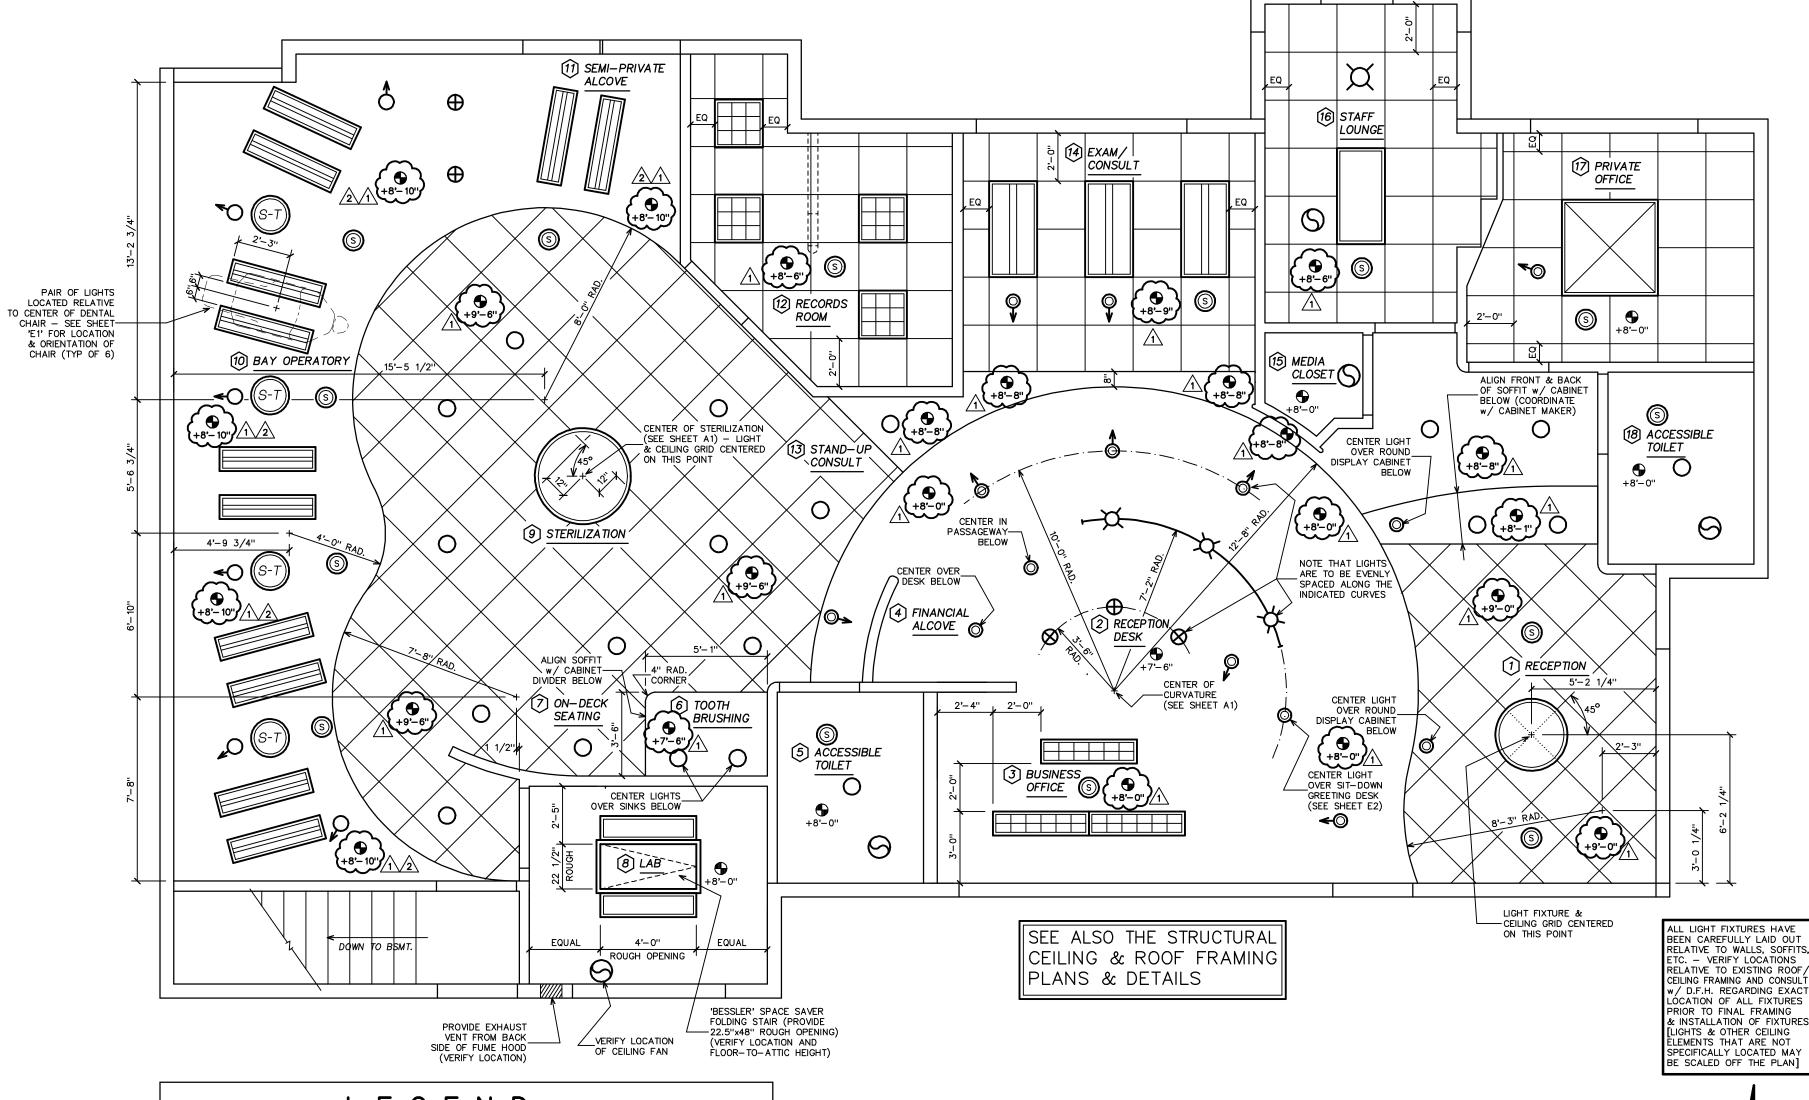

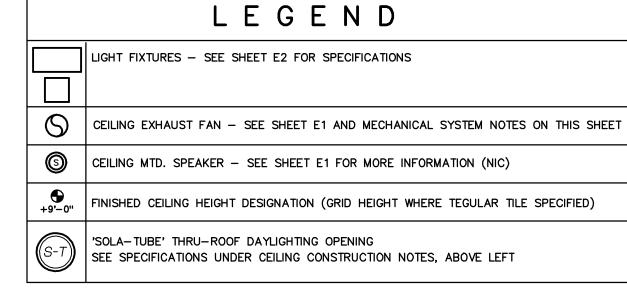

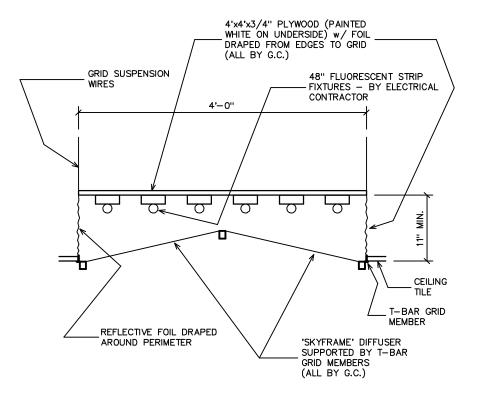

'SKYFRAME' CEILING DETAIL

SCALE: 3/4" = 1'-0"

SEE MFR'S SPECS FOR SF-44
FROM NORTON INDUSTRIES, INC.
(888) 357-2815
FRAME TO MATCH GRID (WHITE
-VERIFY W/ INTERIOR DESIGNER)

FICE FOR OBSUNNYVALE, CALIFORNIA 94087

PHONE: (831) 425-1869 FAX; (831) 425-3905

REVISIONS

|3 JULY, 09 | RMH

|8 JULY, 09 |RMH

SHIMIZU, D

DATE: 20 MAY, 09
SCALE: AS NOTED

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DRAWN: MBG/RMH PROJECT: 20812

SHEET: